



BIDS AND AWARDS COMMITTEE

SUPPLEMENTAL BID BULLETIN NO. 1

Construction of Hatchery Building with Insulated Roof, Cemented Posts and Floor, Full-Capacity Solar Power Electrical System, Electricity and Lighting Fixtures and Foundational Water Piping Layout and Closed Room Allocation for Laboratory

URS-26-02-073

February 18, 2026

This Supplemental Bid Bulletin No. 1 is issued to modify or amend items in the Bid Documents. This shall form an integral part of the Bid Documents.

Section III. Bid Data Sheet

Registered and Licensed Architect	Prepare the complete architectural design of the Catfish Hatchery Building, including floor plans, elevations, sections, schedules, and detailed architectural drawings. Must be a Registered and Licensed Architect with a valid Professional Regulation Commission (PRC) license. Must have at least five (5) years of relevant professional experience in architectural planning and design of buildings, preferably involving agricultural, aquaculture, institutional, or utility-type facilities.
Sanitary Engineer or Master Plumber	Prepare the sanitary and plumbing system design for the Catfish Hatchery Building, including water supply distribution, drainage layout, wastewater disposal, and plumbing details. Must be a Registered Sanitary Engineer or Registered Master Plumber with a valid Professional Regulation Commission (PRC) license. Must have at least five (5) years of relevant professional experience in the design and implementation of water supply, drainage, sanitary, and plumbing systems, preferably for agricultural, aquaculture, laboratory, or institutional facilities.

Materials Engineer I	Must be a licensed Civil Engineer with valid PRC license and duly accredited by DPWH as Materials Engineer I. Must have at least three (3) years of relevant experience in construction materials testing, quality control, and inspection for building or infrastructure projects. Responsible for the conduct, supervision, and evaluation of all required materials testing for the project to ensure compliance with approved plans, specifications, and applicable standards. Prepare and implement the Quality Control and Materials Testing Program covering civil, structural, and related construction works. Assist in the preparation and verification of quality-related documents prior to project turnover.
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Section VII. Drawings


(See attached file)

For guidance and information of all concerned.


ARIEL M. PLANTILLA, DBA
Chairperson, Bids & Awards Committee

SCOPE OF WORKS:

1. Design
 - Detailed Architectural and Engineering Design
 - Preparation of drawings and specifications
2. Site Preparation and Excavation
 - Clearing and leveling of site
 - Excavation for foundation
3. Civil and Structural Works
 - Footings and grade beams
 - Slab on grade
 - Columns and beams
 - Roof trusses framing
4. Tinsmithry Works
 - Supply and installation of roof
5. Doors and Windows Installation
 - Supply and installation of doors
 - Supply and installation of windows and louvers
6. Finishing Works
 - Painting of walls, doors, and frames
 - Floor finishes
7. Plumbing Works
 - Plumbing Fixtures
 - Cold Waterline
 - Sewer Line and Vent System
8. Electrical Works
 - Boxes, Conduits & Fittings
 - Wires & Cables
 - Electrical Fixtures and Devices
 - Panel Boards & Circuit Breakers

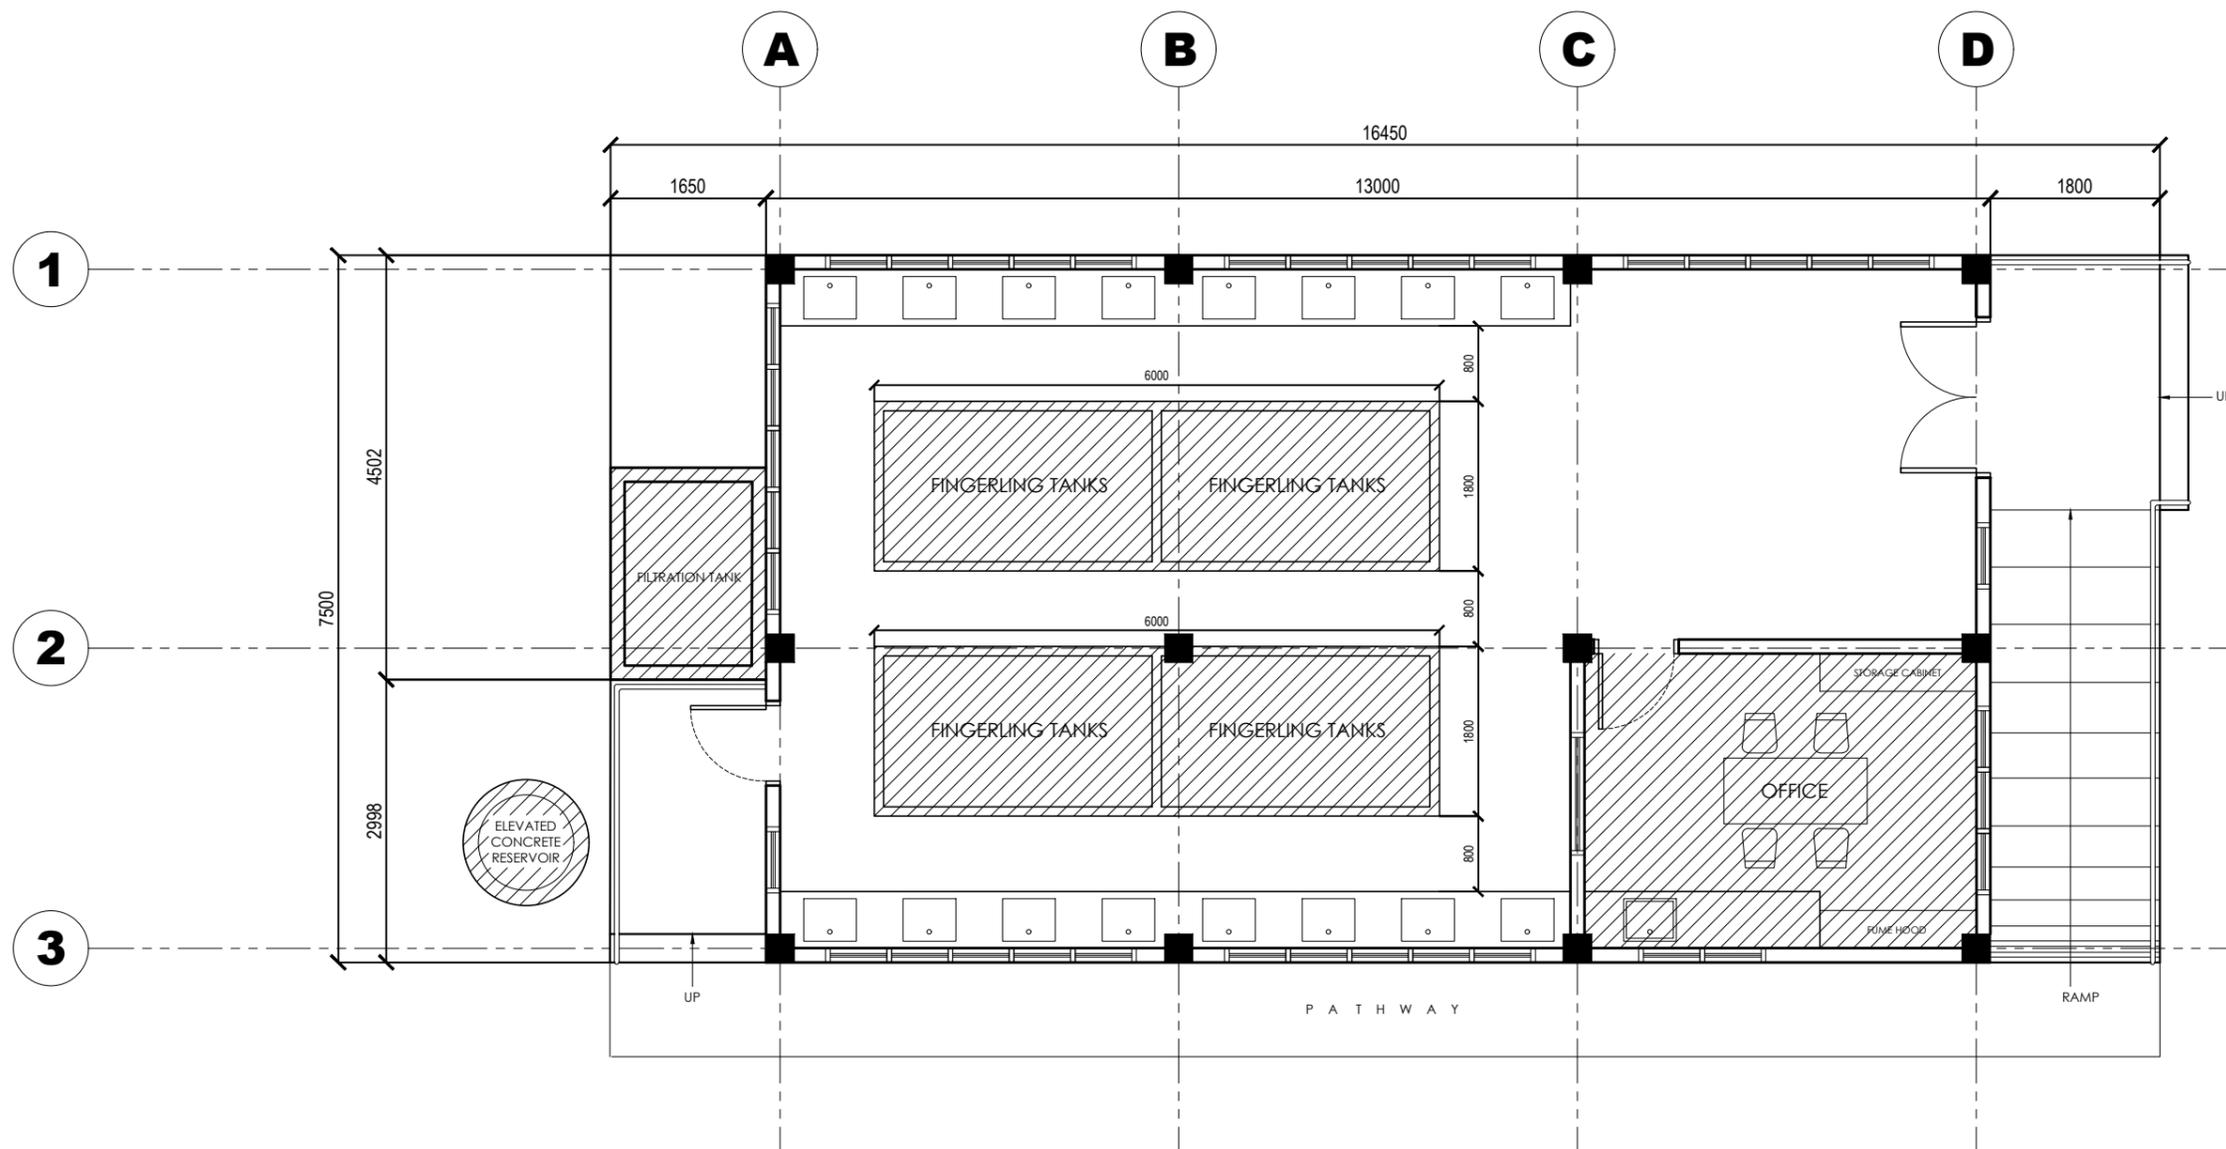

A-1
PROPOSED FLOOR PLAN
1 | 1 SCALE 1:75 MTS.

 UNIVERSITY OF RIZAL SYSTEM UNIVERSITY PROJECT MANAGEMENT UNIT	PROJECT TITLE: CONSTRUCTION OF HATCHERY BUILDING WITH INSULATED ROOF, CEMENTED POSTS AND FLOOR, FULL-CAPACITY SOLAR POWER ELECTRICAL SYSTEM, ELECTRICITY AND LIGHTING FIXTURES AND FOUNDATIONAL WATER PIPING LAYOUT AND CLOSED ROOM ALLOCATION FOR LABORATORY	PREPARED AND DRAWN BY: JOAN MARIE F. TIBURCIO, RCE <small>PROJECT DEVELOPMENT OFFICER I, UPMU</small>	CHECKED BY: JEFREY M. LAWAS, RCE <small>PROJECT DEVELOPMENT OFFICER II, UPMU</small>	SUBMITTED BY: STEVE S.J. MILLARE, RENP <small>HEAD, UPMU</small>	RECOMMENDING APPROVAL: MARVIN P. AMOIN, Ph.D. <small>VICE PRESIDENT FOR ADMINISTRATION AND FINANCE</small>	APPROVED BY: NANCY T. PASCUAL, Ed. D., RGC <small>PRESIDENT</small>	SHEET CONTENT: AS SHOWN	SHEET NO.: A 1
	<small>UNIVERSITY OF RIZAL SYSTEM CARDONA CAMPUS</small>							